#### PUBLIC UTILITIES MSU TO LAKE LANSING CONNECTOR TRAIL, PHASE II **TELEPHONE CONSTRUCTION PLANS** 337 N. ABBOTT, RM. 201 EAST LANSING, MI 48823 517.337.3660 **CONSUMERS ENERGY MERIDIAN TOWNSHIP** 530 W. WILLOW ST. ELECTRIC P.O. BOX 30162 INGHAM COUNTY, MICHIGAN LANSING, MI 48909 517.373.6100 COMCAST CABLE TV 1070 TROWBRIDGE ROAD STANDARD CONSTRUCTION NOTES STATION EAST LANSING, MI 48823 517.332.1012 HASLETT ROAD WATER MAINS MERIDIAN TOWNSHIP of construction within the public right-of-way. 5151 MARSH RD. **SANITARY SEWER** OKEMOS, MI 48864 PATHWAYS 517.853.4440 WOLVERINE PIPE LINE PETROLEUM PIPELINE 8105 VALLEYWOOD LANE be resolved prior to final release and acceptance. PORTAGE, MI 49024-5251 231.323.2491 contractor's obligation to verify the exact location of all existing utilities, which might affect this job. **DRAINS** INGHAM COUNTY DRAIN COMMISIONER STORM SEWER 707 BUHL ST. MASON, MI 48854 517.676.8395 from the money due the contractor. INGHAM COUNTY ROAD DEPT PUBLIC ROADS AND TREATMENT 301 BUSH ST. RIGHTS OF WAY MASON, MI 48854 517.676.9722 **BURCHAM DRIVE** SOIL EROSION & SEDIMENTATION CONTROL NOTES modified proctor unless otherwise noted. All soil erosion and sediment control (SESC) work shall conform to the standards and specifications of the Ingham County Drain Commissioner's Office and Meridian Township. 10. Trees and shrubs are to be protected during construction and bored where necessary. Daily inspections shall be made by the contractor for effectiveness of SESC measures. Any necessary repairs shall be performed without delay. Erosion of any sediment from work on the site shall be contained on-site and not allowed to collect on any off-site areas or in waterways. Waterways include both natural and man-made open ditches, contractor's operations shall be immediately restored. streams, storm drains, lakes, ponds, and wetlands. The Contractor shall apply temporary SESC measures when required and as directed on these plans. The Contractor shall remove temporary measures as soon as permanent stabilization of slopes, 0 General Specifications. ditches, and other changes have been established. Staging the work shall be done by the Contractor as directed in these plans and as required to ensure progressive stabilization of disturbed earth. Soil erosion control practice shall be established in the early stages of construction by the Contractor. Sedimentation control practices shall be applied as a perimeter defense against any transporting of soil off the site. The Contractor shall preserve natural vegetation as much as possible Vegetative stabilization of all disturbed areas shall be established within 15 days of completion of the TOWNSHIP MILLINGS STOCKPILE **PATHWAY NOTES** Pathways and sidewalks shall be four (4) inch thick concrete except at driveways where they shall be six (6) inch (residential) or seven (7) inch (commercial) thick concrete. MUD LAKE DRAIN Property irons shall be maintained by the Contractor. considered incidental to construction. All aggregate base material shall be four (4) inches of 22A. PROJECT LOCATION with guidelines established by the A.N.L.A. **SOILS:** All plant material not marked for removal shall be protected. BrB - Boyer sandy loam, 0 to 6 percent slopes Co - Colwood-Brookston loams CENTRAL PARK DRIVE

OKEMOS

GRAND RIVER AVE (M-43)

 $\approx$ 

POST OFFICE

Hn - Houghton muck

KbA - Kibbie loam, 0 to 3 percent slopes

MrA - Matherton sandy loam, 0 to 3 percent slopes

OtB - Oshtemo-Spinks loamy sands, 0 to 6 percent slopes OtC - Oshtemo-Spinks loamy sands, 6 to 12 percent

OwC - Owosso-Marlette sandy loams, 6 to 12 percent slopes

OwB - Owosso-Marlette sandy loams, 2 to 6 percent slopes

RECOMMENDED CONSTRUCTION SCHEDULING & SEQUENCING	JANUARY	FEBRUARY	MARCH	APRIL	MAY	JUNE	JULY	AUGUST	SEPTEMBER	OCTOBER	NOVEMBER	DECEMBED
INSTALL SESC MEASURES												
PERFORM COMPENSATING CUTS												
ROUGH GRADE FOR TRAIL												
INSTALL HMA TRAIL												
CLEANUP AND RESTORATION												
REMOVE SESC MEASURES												





- The Contractor shall notify the Charter Township of Meridian, Department of Public Works, Office of Engineering 517-853-4440 a minimum of 72 hours prior to the start of construction of public utilities or
- All construction shall conform to the current standards and specifications of the Charter Township of Meridian which are included as part of these plans in effect at the time of construction.
- After the completion of construction of public utilities or construction within public right-of-way, the contractor must request a final inspection. Any punchlist items resulting from the final inspection must
- 4. The existing utilities indicated on the plans are in accordance with available information. It shall be the
- The contractor shall notify "MISS DIG" 1-800-482-7171 at least 72 hours prior to the start of
- The contractor shall at all times be aware of inconvenience caused to the abutting property owners and the general public. Where the contractor does not remedy undue inconveniences, the Charter Township of Meridian, upon four hours notice, reserves the right to perform the work and deduct the cost therefore
- A Registered Land Surveyor provided by the contractor at the contractor's expense shall replace all property irons and monuments disturbed or destroyed by the contractor's operations.
- Contractor shall provide Owner and Township Engineer a copy of written permission to use private property for storage of equipment and materials or for his construction operations.
- Trench backfill under existing or proposed roadways, driveways, and parking areas, shall be sand or gravel, placed in 12" layers (maximum) and consolidated to 95% of maximum density as measured by
- 11. Existing fences shall be removed and restored to their original condition or better where in conflict with
- 12. Driveways, culverts, ditches, drain tile, tile fields, drainage structures, etc., that are disturbed by the
- 13. All established lawn areas disturbed by the contractor's operations shall be resodded with matching sod. All other areas shall be seeded and mulched. Seeding and mulching shall be done in accordance with the
- 14. All ditch slopes shall have established vegetation and be protected from erosion.
- 15. All utility poles in close proximity to construction shall be supported in a manner satisfactory to the
- 16. Onsite parking and sanitary facilities shall be provided for construction workers. The facilities shall be constructed and operated (with minimal impact to the surrounding area) to the satisfaction of the
- 2. Three (3) inches of compacted sand base shall be placed under all pathways and sidewalks.
- All bituminous aprons shall be two and one-half  $(2\frac{1}{2})$  inches thick, unless otherwise noted.
- All existing concrete and bituminous to be removed shall be sawcut. All bituminous removal shall be
- All tree (less than 6") and shrub removal shall be considered part of subgrade preparation.
- Location of new plant material shall be as directed by the Engineer, and shall be installed in accordance
- 10. Bituminous drives shall be sawcut 18" on either side of proposed pathway.
- 11. The maximum longitudinal slope is 5% (up to an absolute maximum of  $8\frac{1}{3}$ % at the direction of the Engineer) and the maximum cross slope is 2%.
- 13. Expansion joints shall be placed at approximately 100' intervals and shall be  $\frac{1}{2}$ " thick. Contraction joints shall be sawcut to a depth of  $\frac{1}{4}$  of the depth of the concrete.
- 14. All lumber to be pressure treated (Osmose 33 or equal) to 0.4 retention.
- 15. All items not covered under a specific pay item shall be considered incidental.


#### **SHEET INDEX**


TITLE **COVER SHEET** 0+00 - 12+00 12+00 - 24+00 24+00 - 36+00 36+00 - END TYPICAL DETAIL SHEET PATHWAY DETAIL SHEET

SHEET 1 OF 7

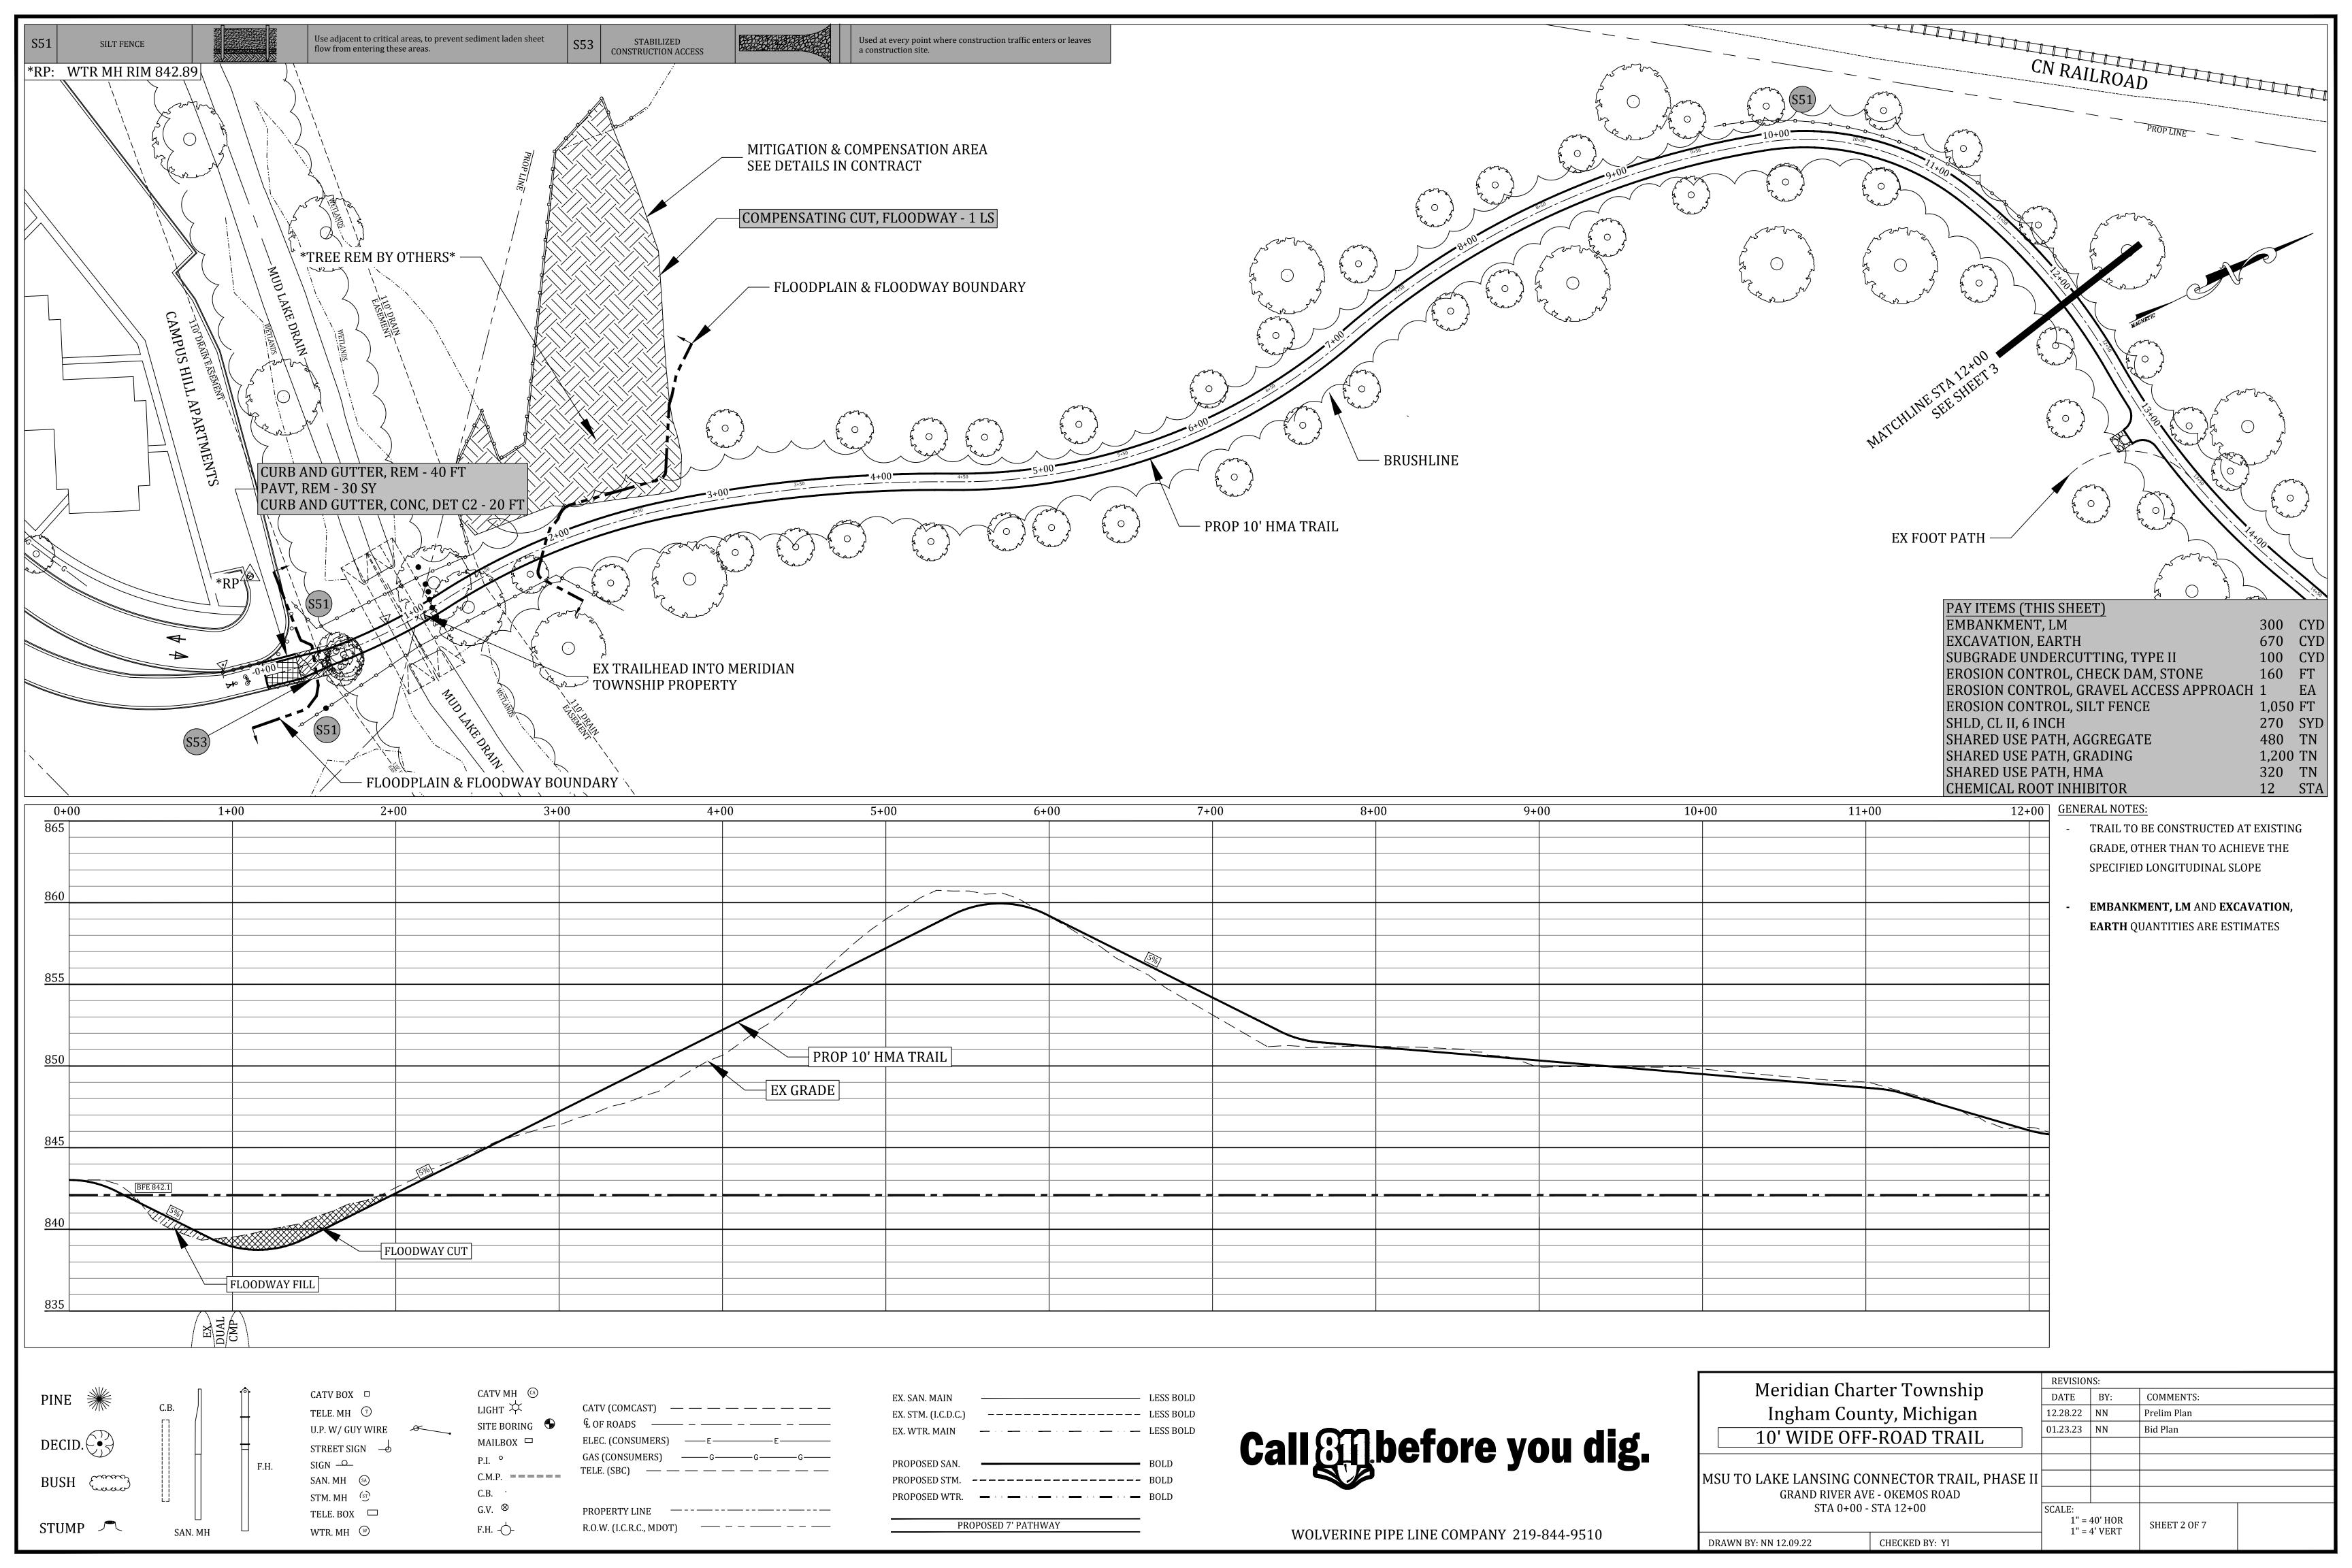

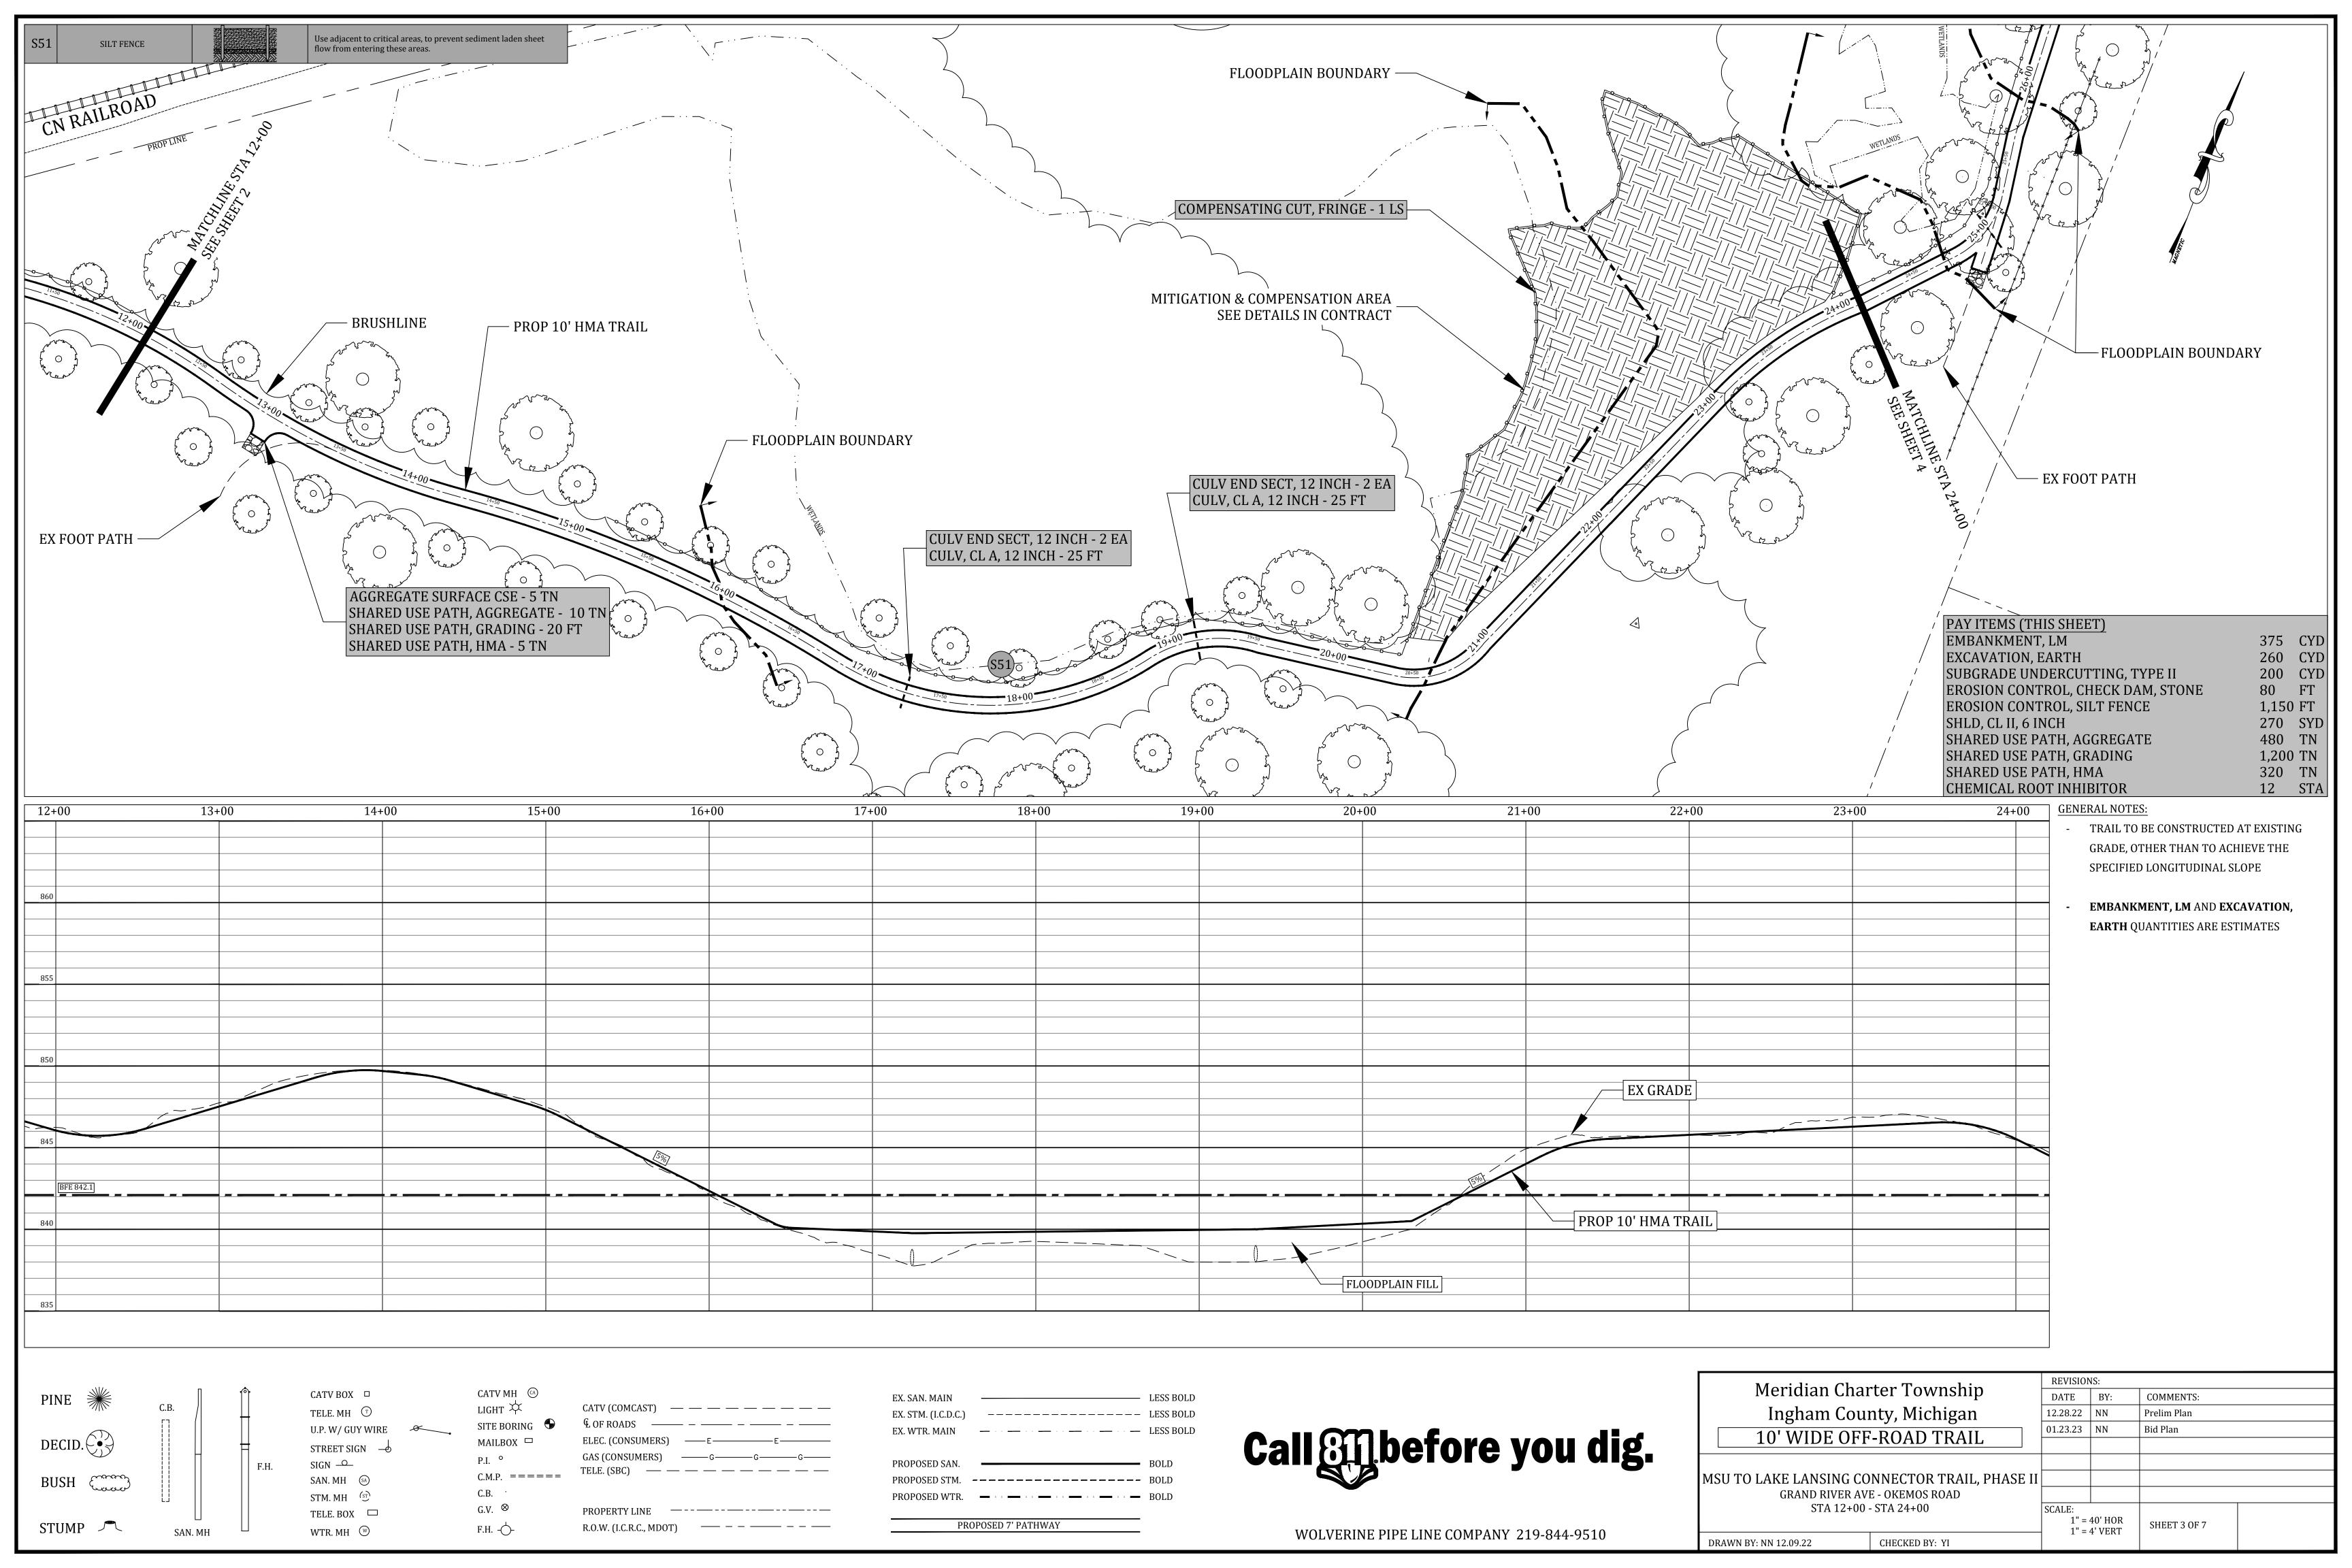

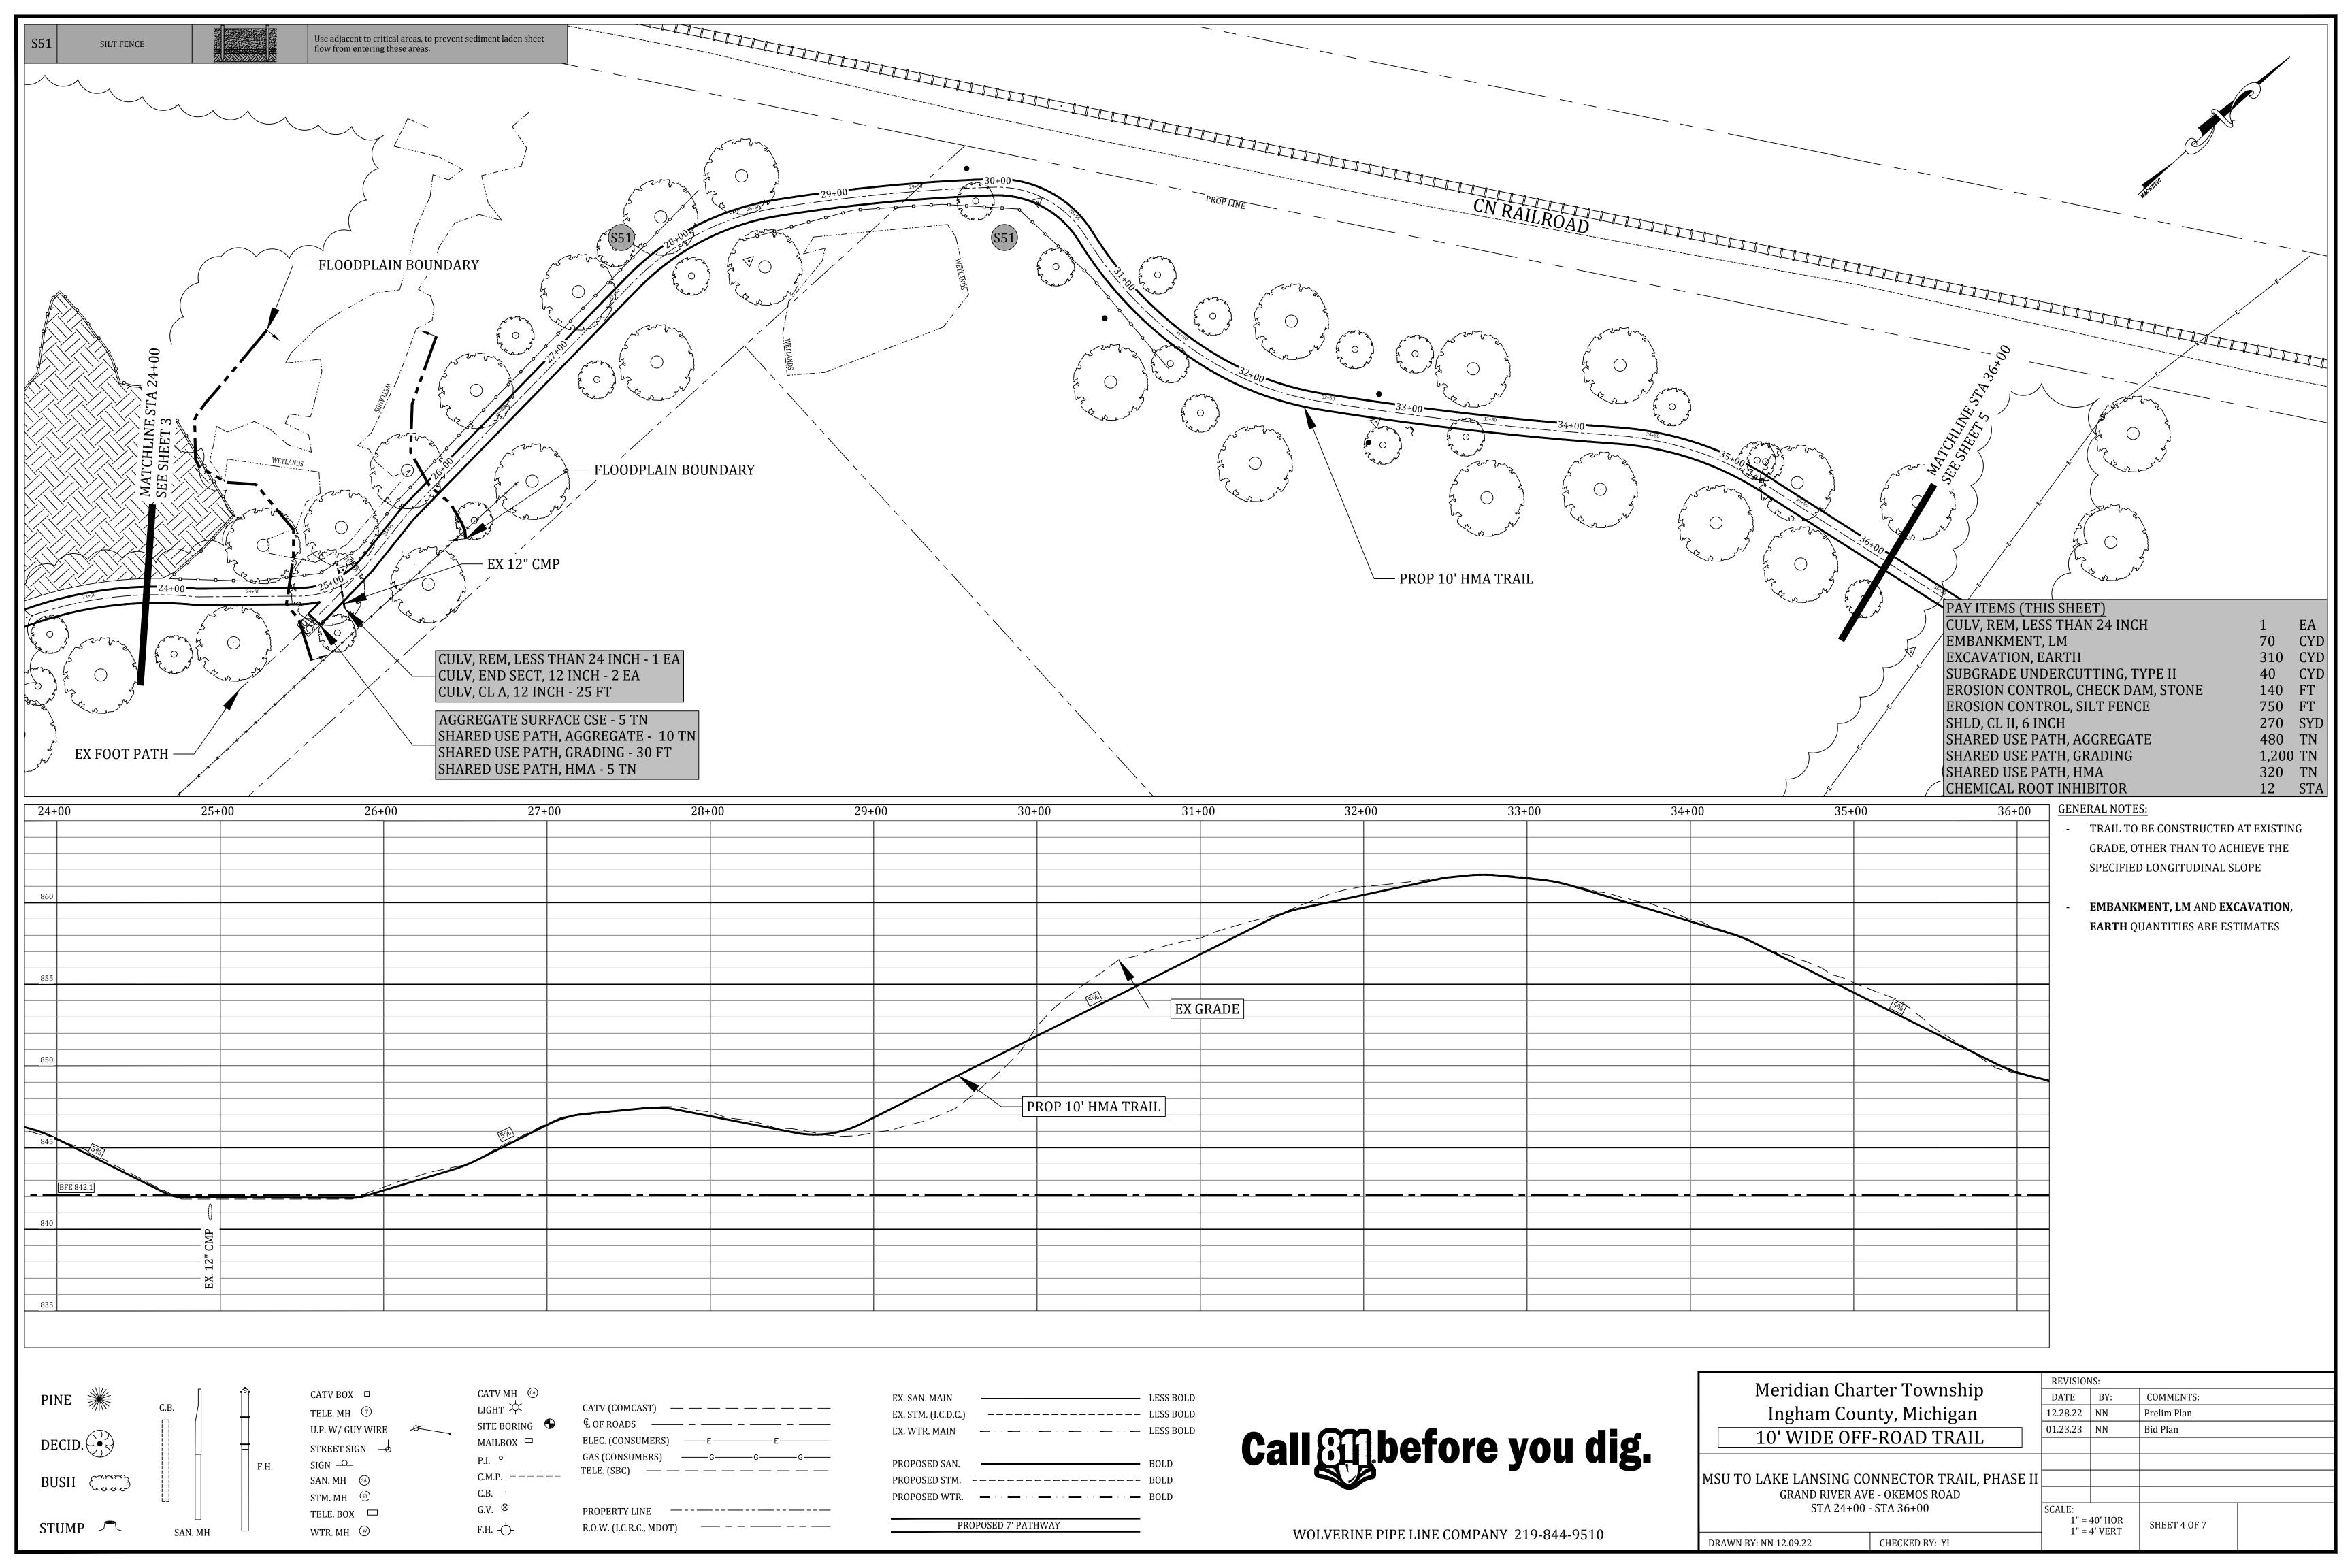

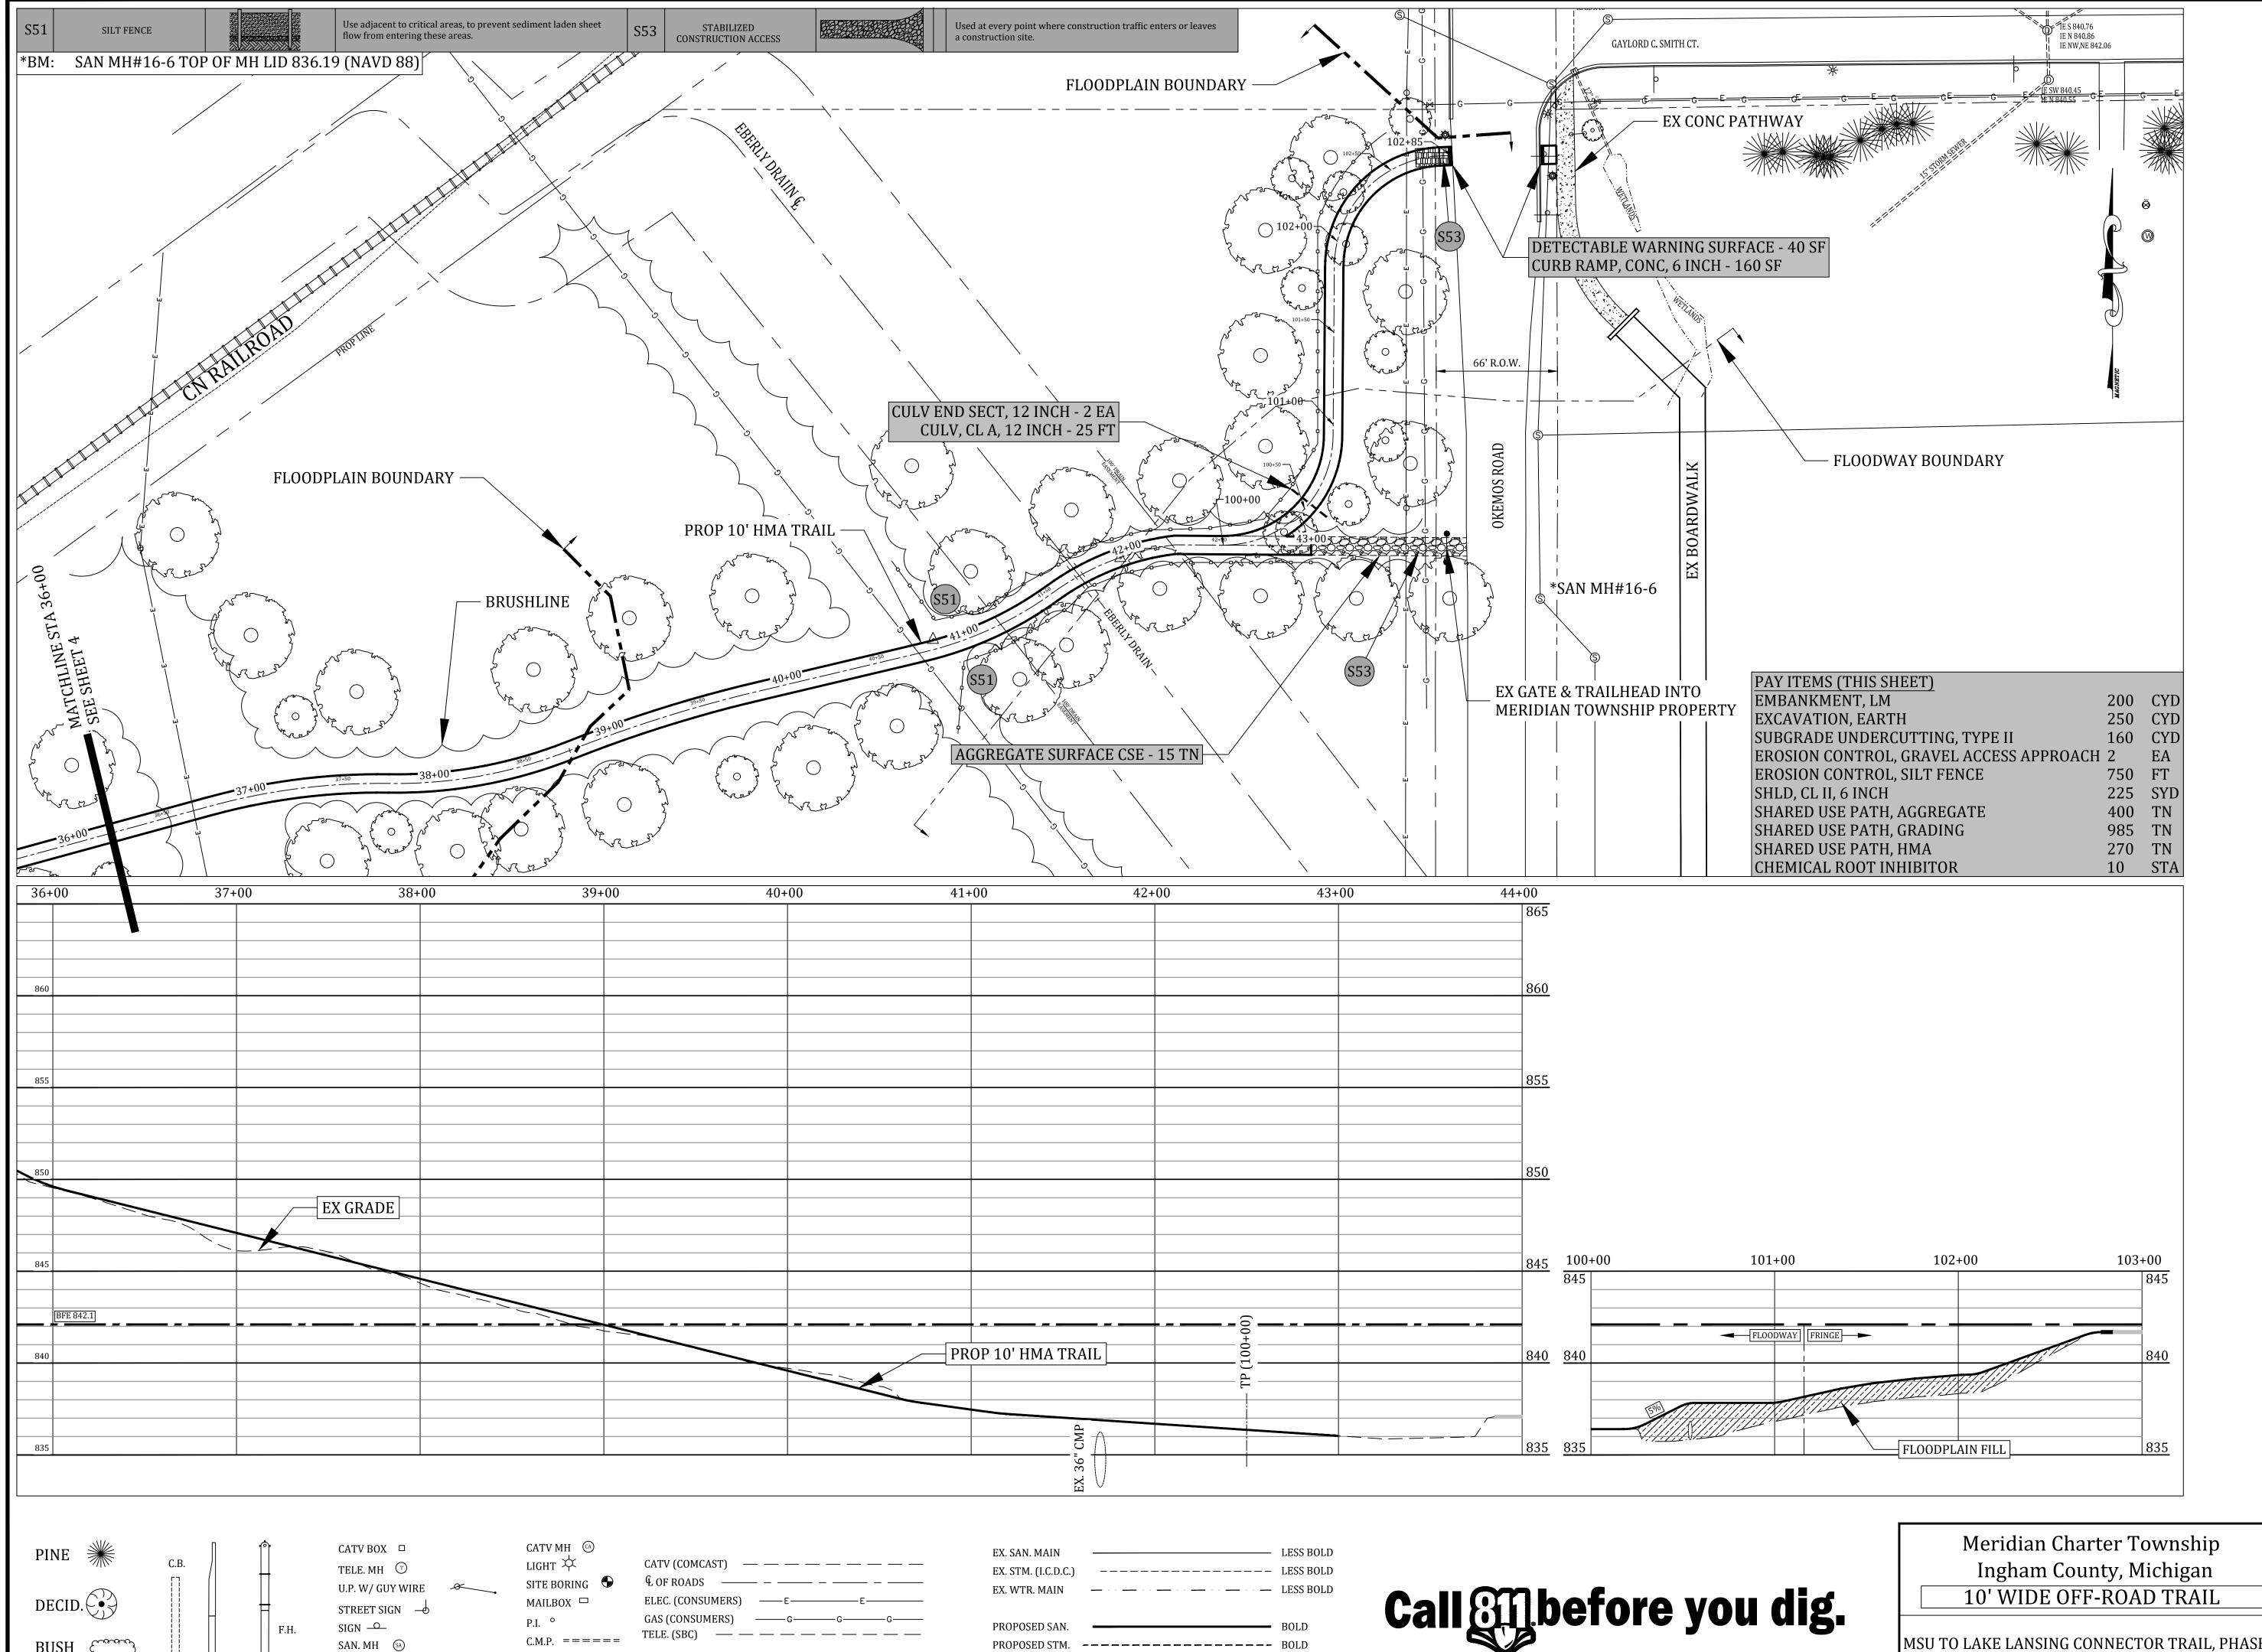

PROPOSED 7' PATHWAY

C.B.

 $_{\text{G.V.}}$   $\otimes$ 

F.H. -

PROPERTY LINE —--—--

R.O.W. (I.C.R.C., MDOT) —— — — — — — — —

STM. MH

WTR. MH W

STUMP 🦯

TELE. BOX

# GENERAL NOTES:


- TRAIL TO BE CONSTRUCTED AT EXISTING GRADE, OTHER THAN TO ACHIEVE THE SPECIFIED LONGITUDINAL SLOPE
- EMBANKMENT, LM AND EXCAVATION, **EARTH** QUANTITIES ARE ESTIMATES

Call before you dig.

WOLVERINE PIPE LINE COMPANY 219-844-9510

CHECKED BY: YI DRAWN BY: NN 12.09.22

Maridian Chartan Tayunahin				REVISIONS:						
Meridian Charter Township			DATE	BY:	COMMENTS:					
	Ingham Cou	nty, Michigan	1	12.28.22	NN	Prelim Plan				
		-ROAD TRAIL	0	)1.23.23	NN	Bid Plan				
	10 WIDL OIT	ROND TRILL								
MSU TO LAKE LANSING CONNECTOR TRAIL, PHASE II										
GRAND RIVER AVE - OKEMOS ROAD										
STA 36+00 - END			S	SCALE: 1" = 40' HOR		SHEET 5 OF 7				
				——————————————————————————————————————						

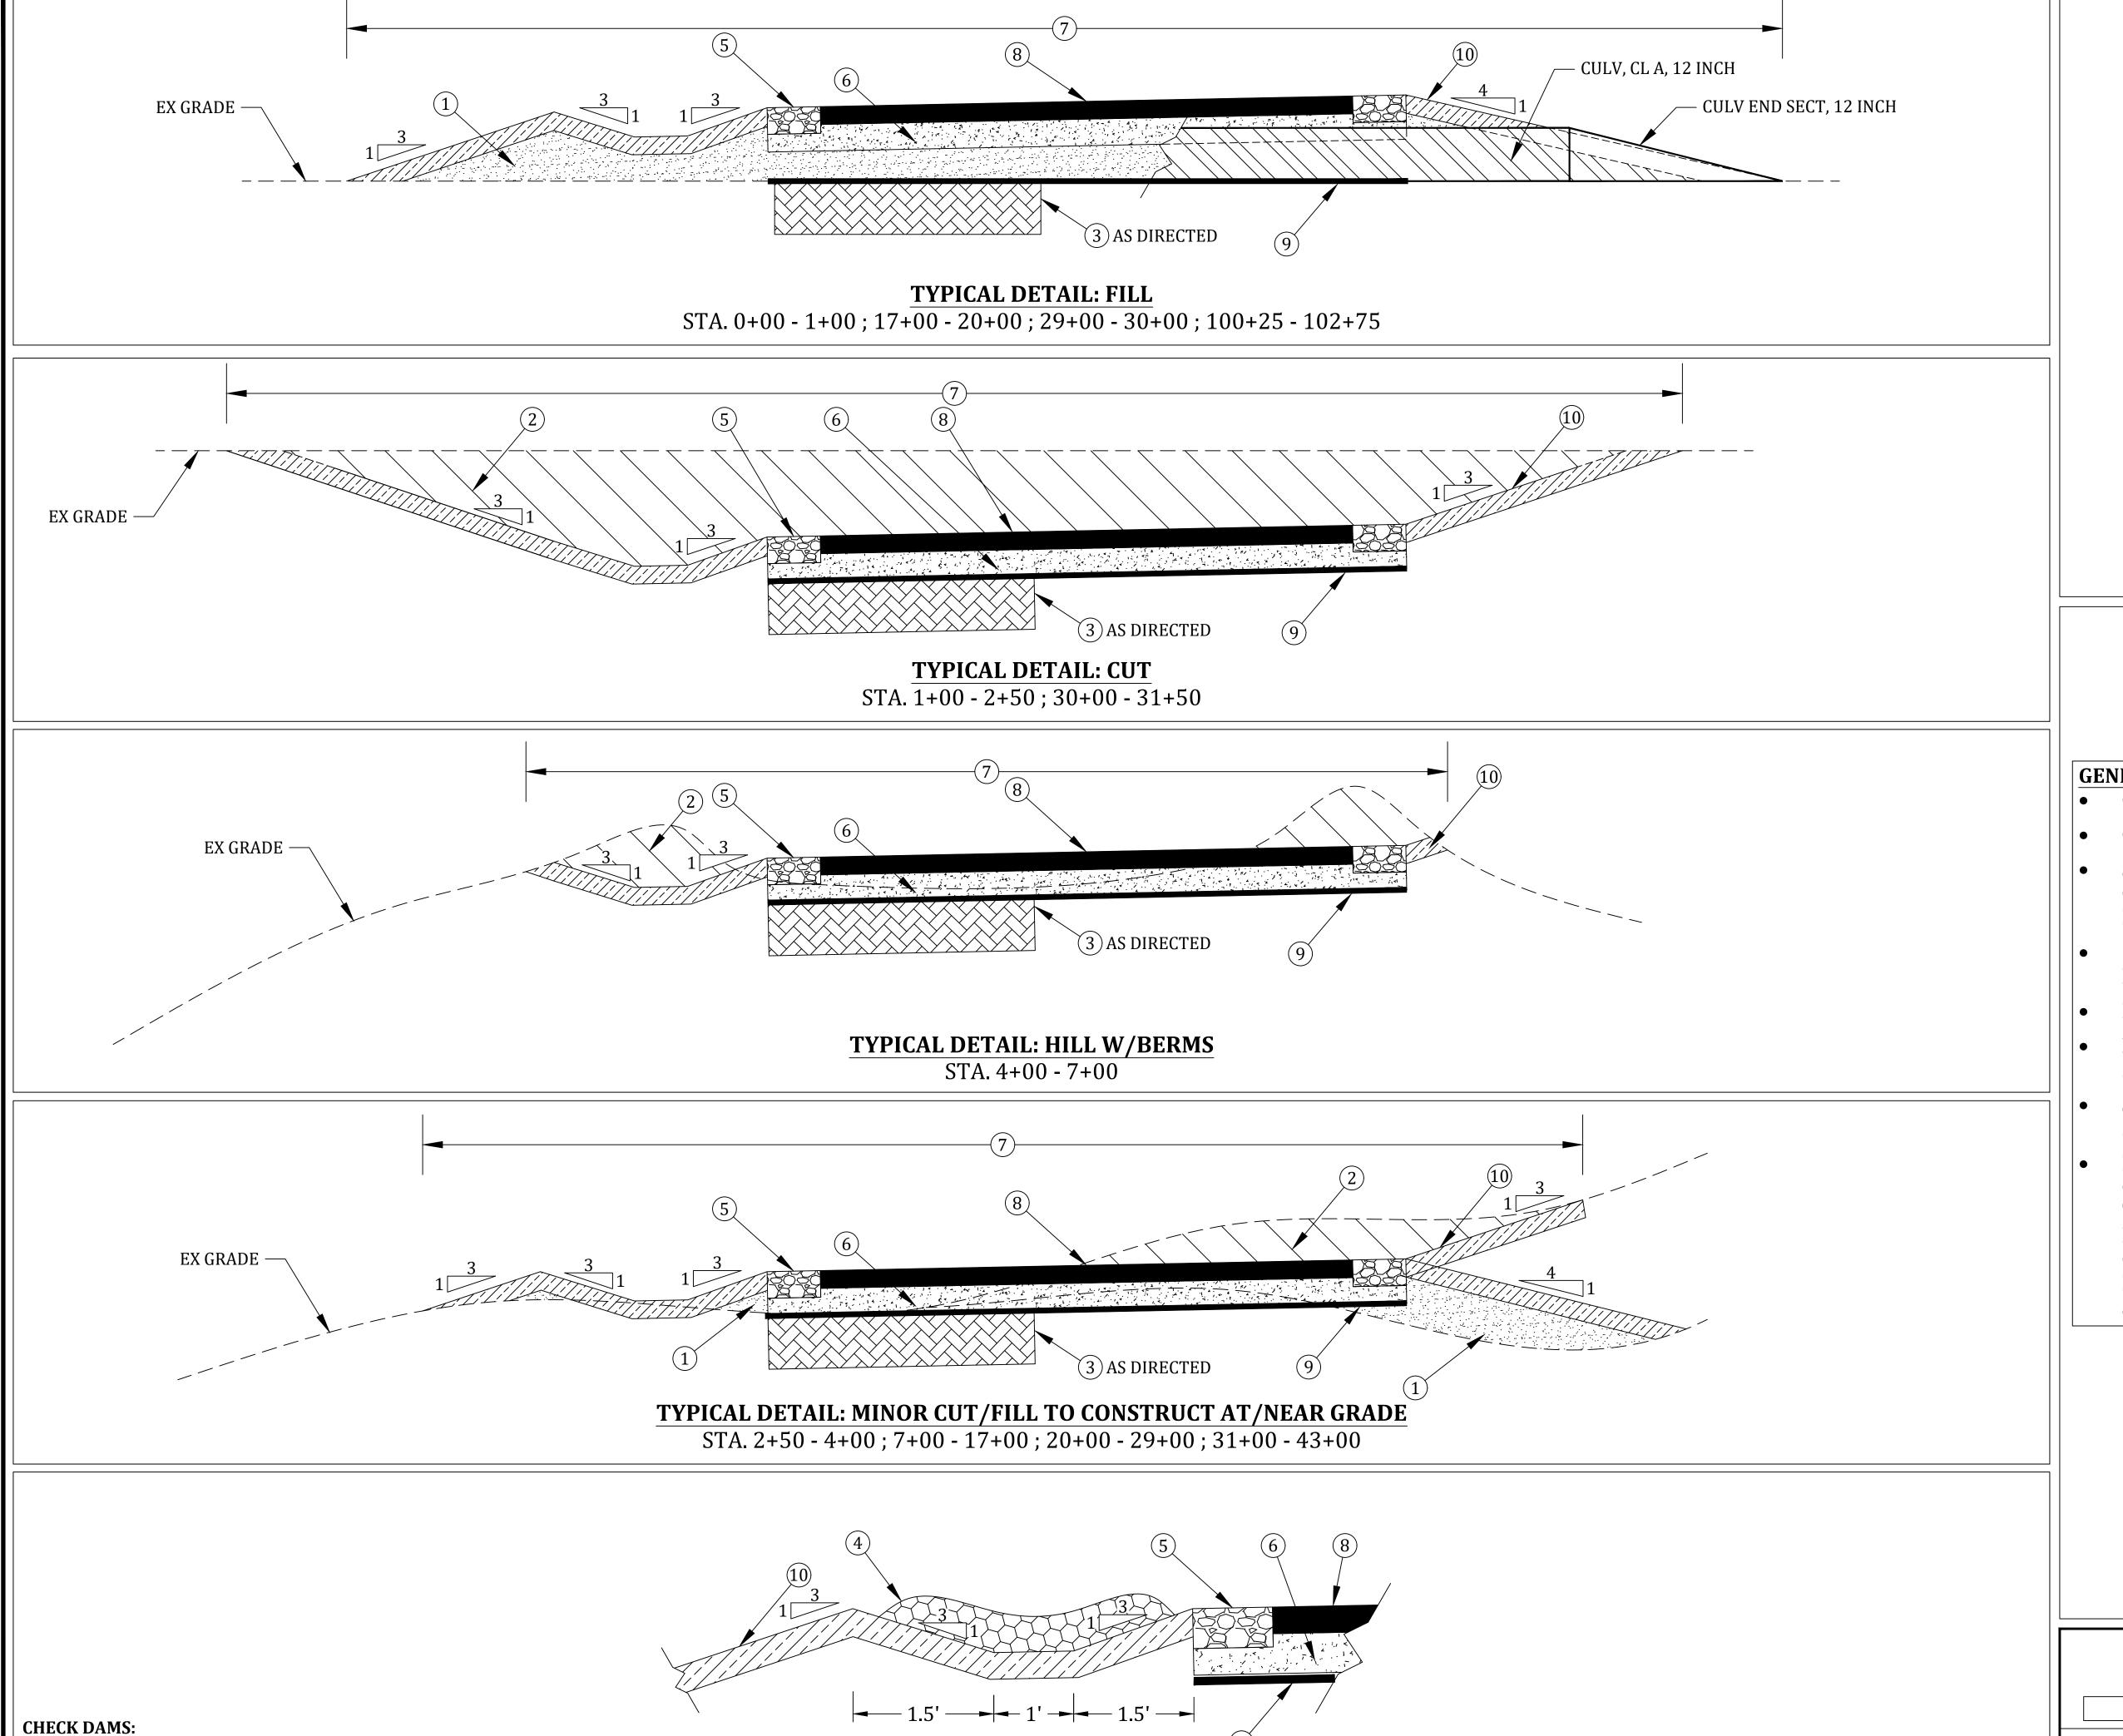

TYPICAL DETAIL: SWALE (POST CONSTRUCTION RUNOFF MITIGATION)

STA. \*ALL\*

-USE CHECK DAMS FOR SWALE GRADES 3-5%.

-USE 1-3" CRUSHED, WASHED STONE OR CONCRETE.

-SPACE OUT CHECK DAMS AT 20' O.C.

## **PAY ITEM LEGEND:**

- 1 EMBANKMENT, LM
- (2) EXCAVATION, EARTH
- (3) SUBGRADE UNDERCUTTING, TYPE II
- (4) EROSION CONTROL, CHECK DAM, STONE
- (5) SHLD, CL II, 6 INCH
- (6) SHARED USE PATH, AGGREGATE (6 INCH DEEP)
- (7) SHARED USE PATH, GRADING
- (8) SHARED USE PATH, HMA
- (9) CHEMICAL ROOT INHIBITOR
- (10) SITE RESTORATION (3" SCREENED TOPSOIL)

PAY ITEMS & QUANTITIES (MISC):			
MOBILIZATION, MAX	1	LS	
TRAFFIC CONTROL	1	LS	
SITE RESTORATION	1	LS	

### **GENERAL NOTES:**

- CROSS-SECTIONS ARE NOT TO SCALE.
- CROSS-SECTIONS ARE LOOKING DOWN-STATION.
- SALVAGE OR REMOVE EXISTING TOPSOIL WITHIN THE GRADING LIMITS, OR AS DIRECTED BY THE ENGINEER. REMOVAL AND DISPOSAL WILL BE PAID FOR AS **EXCAVATION**, **EARTH**.
- TOPSOIL FOR **SITE RESTORATION** MAY BE SALVAGED FROM SITE, BUT MUST BE SCREENED OR RAKED TO REMOVE 1" OR GREATER DEBRIS.
- FOR **SITE RESTORATION**, USE SEED MEETING MDOT THM MIXTURE.
- **EMBANKMENT, LM** SHALL BE CLASS II GRANULAR MATERIAL OR ASPHALT MILLINGS.
- **SHARED USE PATH, AGGREGATE** SHALL BE 21AA AGGREGATE OR ASPHALT MILLLINGS.
- FOR EMBANKMENT, LM AND SHARED USE PATH, AGGREGATE THE CONTRACTOR MAY USE MILLINGS FROM THE STOCKPILE AT MERIDIAN TOWNSHIP'S SERVICE CENTER. THERE ARE MORE THAN ENOUGH MILLINGS FOR ALL OF THE FILL REQUIRED ON THIS PROJECT. THE CONTRACTOR WILL BE RESPONSIBLE TO PROVIDE THE LABOR AND EQUIPMENT TO LOAD AND TRANSPORT THE MILLINGS FROM THE STOCKPILE LOCTION TO THE CONSTRUCTION SITE.

HMA APPLICATION TABLE								
COURSE	MIX TYPE	YIELD (#/SY)	BINDER	BOND COAT (GAL/SY)	TAV (%)			
BASE	13A	220	58-28	0.05-0.15	4			
ТОР	13A	220	58-28	0.05-0.15	3			

ESTIMATED CUT/FILL QUANTITIES: TOTAL CUT- 130 CY TOTAL FILL- 705 CY

Maridian Cha	REVISIONS:						
meridian Cha	rter Township	DATE	BY:	COMMENTS:			
Ingham Cou	nty, Michigan	12.28.22	NN	Prelim Plan			
10' WIDE OFF	01.23.23	NN	Bid Plan				
TO WIDE OF	-NOAD TRAIL						
ISU TO LAKE LANSING CO	ONNECTOR TRAIL, PHASE II						
GRAND RIVER AV							
TYPICAL DETAIL SHEET			4017705				
			40' HOR 4' VERT	SHEET 6 OF 7			
DRAWN BY: NN 12.09.22	CHECKED BY: YI		. ,				

